GLENN COUNTY

Planning & Community Development Services Agency

225 North Tehama Street Willows, CA 95988 530.934.6540 www.countyofglenn.net



Mardy Thomas, Director

Michael Anthony 6329 County Road 7 Orland, CA 95963

Phone: (530) 774-4840

Email: dmadrigal11@gmail.com

RE: Site Plan Review 2023-007, Anthony

APN: 044-150-015

October 3, 2023

To Whom It May Concern,

On September 8, 2023, the Glenn County Planning & Community Development Services Agency received your application for a Site Plan Review. This project is located in the "AE-20" (General Agriculture) zoning district and is an allowed use with an approved Site Plan Review.

On October 3, 2023, the Glenn County Planning & Community Development Services Agency approved the Site Plan Review. Included with the Staff Report is a copy of the Compliance Requirements.

Please sign the Compliance Requirements as indicated and return by email, or send to the Glenn County Planning & Community Development Services Agency, at 225 N Tehama Street, Willows, CA 95988.

Please note that this is not a building permit. For information on acquiring a building permit, contact the Glenn County Building Inspection Division at (530) 934-6546.

Sincerely,

Courtney Paget
Assistant Planner
cpaget@countyofglenn.net

GLENN COUNTY Planning & Community Development Services Agency

225 North Tehama Street Willows, CA 95988 530.934.6540 www.countyofglenn.net



STAFF REPORT

DATE: October 3, 2023

FROM: Courtney Paget, Assistant Planner

RE: Site Plan Review 2023-007, Agriculture Storage Building

"AE-20" Exclusive Agricultural Zone

Attachments:

- 1. Compliance Requirement(s)
- 2. Agency Comments
- 3. Request for Review
- 4. Application Materials
- 5. Site Plan

Site Plan Review 2023-007 Page 1 of 6

1 PROJECT SUMMARY

An application for an Agriculture Storage Building has been received. The exterior dimensions of the structure are 30 feet by 60 feet (1,800 square feet) with a peak height of 15 feet.

The project is located at 6329 County Road 7, north of County Road 9, west of Interstate 5, east of County Road FF, and south of County Road 7, in the unincorporated area of Glenn County, California.

The Assessor's Parcel Number (APN) for the 23.23± acre site is 044-150-015. The site is zoned "AE-20" Exclusive Agriculture (17-acre minimum parcel size) and is designated "General Agriculture" in the Glenn County General Plan.

1.1 RECOMMENDATIONS

Staff recommends that the Director find that this project qualifies as a statutory exemption within section 15268 of the California Environmental Quality Act.

Staff also recommends that the Director approve the Site Plan Review with the Findings as presented in the Staff Report and the Compliance Requirement as attached.

2 ANALYSES

The proposed project is consistent with the land use in this area. This area of Glenn County is agricultural and the proposed project is a permitted use with an approved Site Plan Review. A Site Plan Review is required prior to construction to ensure compliance with all the requirements of the Glenn County Code.

This proposal will not have significant additional accompanying traffic; the property is used for a residence and agriculture and the uses will not be altered with this proposal. Surrounding county roads are reasonably adequate to safely accommodate the proposed project (Finding 5).

2.1 ENVIRONMENTAL DETERMINATION

This project as proposed is not anticipated to introduce potentially significant impacts to the environment.

Site plan reviews are statutorily exempt pursuant to Section 15268, "Ministerial Projects", of the Guidelines of the California Environmental Quality Act (CEQA). Article 18 (Statutory Exemptions), §15268 (a) & (c) (Ministerial Projects).

Site plan reviews, outlined in Section 25.130 of the Glenn County Code, are deemed a ministerial project within Glenn County Title 15, Unified Development Code (Title 15, Division 2, Part 1).

Site Plan Review 2023-007 Page 2 of 6

2.2 GENERAL PLAN AND ZONING CONSISTENCY

The site is designated "General Agriculture" in the Glenn County General Plan and is zoned "AE-20" Exclusive Agriculture (17-acre, minimum parcel size). The site is in an area of existing agriculture, where storage structures are permitted use within the "AE-20" zone with an approved Site Plan Review (Glenn County Chapter 15.33.030.N) (Finding 1). The proposal will not adversely affect the surrounding uses in the area and will not adversely affect the General Plan (Finding 4).

2.2.1 "AE" EXCLUSIVE AGRICULTURAL ZONE (Glenn County Code Chapter 15.330):

Permitted Uses (Glenn County Code §15.33.030):

The proposed project is for a storage structure and is a permitted use under Glenn County Code §15.33.030. N.

Maximum Building Height (Glenn County Code §15.33.060):

The peak height of the proposed structure is 15 feet and will be less than the maximum height requirement for the Exclusive Agriculture Zone of 50 feet per §15.33.060. B.

Minimum Distance Between Structures (Glenn County Code §15.33.070):

The proposed storage structure and is located minimally 85 ft. from property lines; therefore, Glenn County Code §15.33.070. B. will be met.

Minimum Yard Requirements (Glenn County Code §15.33.080):

The proposed front, side, and rear yards exceed 30 feet; therefore, the minimum yard requirements for the Exclusive Agriculture Zone will be met.

2.3 GENERAL PROVISIONS

Flood Zone Designation:

The project site is located within Flood Zone "X." The property is located in both Flood Zone "X" and Flood Zone "A." Flood Zone "X" according to Flood Insurance Rate Map (FIRM) No. 06021C0165D, dated August 4, 2010 issued by the Federal Emergency Management Agency (FEMA). Flood Zone "X" is a flood zone area of minimal flood hazard, with a flood level above the 500-year flood, according to FIRMS. Additionally, "X" flood area is generally protected by levee form 100-year floods.

Flood Zone "A" according to Flood Insurance Rate Map (FIRM) No. 06021C0165D, dated August 4, 2010 issued by the Federal Emergency Management Agency (FEMA). Flood Zone "A" (unshaded) consists of areas subject to inundation by the 1-percent-annual-chance flood event generally determined using approximate methodologies. Because detailed hydraulic analyses have not been performed, no Base Flood elevations (BFEs) or flood depths are shown.

Code Violations:

There is no record of a violation on the property. No current violations on the property exist; therefore, the proposed building and Site Plan Review are compliant with Glenn County Code §15.13.050. F (Finding 6).

Site Plan Review 2023-007 Page 3 of 6

Glenn County Agricultural Commissioner

The Glenn County Agricultural Commissioner was provided the application information regarding the proposal and no comments were received.

Glenn County Air Pollution Control District/CUPA

The Glenn County Air Pollution Control District/CUPA was provided the application information regarding the proposal and no comments were received.

Glenn County Assessor

The Glenn County Assessor was provided the application information regarding the proposal and no comments were received.

Glenn County Building Inspector

The Glenn County Building Inspector was provided the application information regarding the proposal and no comments were received.

Public Works Agency:

The Glenn County Public Works Agency was provided the application information regarding the proposal and replied with no comment.

Environmental Health

The Glenn County Environmental Health Department was provided the application information regarding the proposal and recommended it be found complete for further processing. They also responded with the following:

Comment:

- 1. The parcel has a water well, onsite wastewater treatment system and replacement area for the existing residences.
- 2. The proposed Ag storage building not approved for any wastewater discharge. Any future proposed wastewater discharge shall be approved under permit by the Environmental Health Department (EHD).

Glenn County Sheriff's Department

The Glenn County Sheriff's Department was provided the application information regarding the proposal and no comments were received.

Pacific Gas and Electric Company

Pacific Gas and Electric Company (PG&E) was provided the application information regarding the proposal and replied with no comments or conditions, as per the attached response letter.

Fire Protection Regulations:

This project lies within the Orland Rural Fire Protection District. The fire district was provided the application information regarding the proposal and no comments were received.

Site Plan Review 2023-007 Page 4 of 6

3 NOTICES TO APPLICANT/AGENT

This site plan review is not a building permit. It is the applicant's responsibility to secure the necessary permits in all affected federal, state, and local agencies and submit copies of such permits to the Planning & Community Development Services Agency.

If upon approval of this site plan review any problem, nuisance, or health hazard arises from the operation allowed by this review, the director shall determine the need to revise or modify the use or require additional Compliance Requirements.

In addition to the staff report and Compliance Requirement(s), the applicant's and project management representative's attention is directed to any comments from agencies reviewing the application. The items noted are a guide to assist in meeting the requirements of applicable government codes. Comments may also note any unusual circumstances that require special attention. The items listed are a guide and not intended to be a comprehensive summary of all codified requirements or site-specific requirements.

3.1 PERMIT ISSUANCE AND APPEAL PERIOD (GLENN COUNTY CODE §15.13.060)

Site plan reviews shall be effective upon issuance, unless within ten (10) calendar days of a decision by the Director, the decision is appealed as provided for in Section 15.05.010. In the case of an appeal being filed, the site plan review permit shall not have any force or effect until a decision is made by the Approving Authority on such an appeal.

Additionally, site plan review permit approvals shall not be valid until the permittee has agreed in writing to each term and requirement thereof.

4 FINDINGS

As described and found in this report, and in accordance with Glenn County Code Section 15.13.050.

Finding 1:

The proposed use is a permitted and allowed use in the "AE-20" zoning district.

Finding 2:

The site for the project is adequate in size, shape, location, and physical characteristics to accommodate the proposed project.

Finding 3:

Based on agency review of the project, there are adequate public or private services, including but not limited to fire protection, water supply, sewage disposal, and storm drainage.

Site Plan Review 2023-007 Page 5 of 6

Finding 4:

The project is in conformance with the applicable provisions and policies of Title 15 of the Glenn County Code and the Glenn County General Plan.

Finding 5:

The county roads which serve the project are reasonably adequate to safely accommodate the proposed project.

Finding 6:

After searching county records, no violation of the Glenn County Code currently exists on the property.

Site Plan Review 2023-007 Page 6 of 6

COMPLIANCE REQUIREMENTS

Site Plan Review 2023-007, Anthony

Agriculture Storage Building

APN: 044-150-015

Compliance Requirement: Site Plan

1. That the area of operation shall be confined to those areas as shown on the site plan as submitted and on file at the Glenn County Planning & Community Development Services Agency.

Compliance Requirement: Environmental Health

2. The proposed Ag storage building is not approved for any wastewater discharge. Any future proposed wastewater discharge shall be approved under permit by the Environmental Health Department.

Acknowledgment:

I hereby declare that I have read the foregoing requirements that they are in fact the requirements that were imposed upon the granting of this permit, and that I agree to abide fully by said conditions. Additionally, I have read the staff report and I am aware of codified county, state, and/or federal standards and regulation that shall be met with the granting of this permit.

Signature:		Date:	
	Michael Anthony, Applicant/Landowner		
Signature:		Date:	
	Kristine Anthony, Applicant/Landowner		



September 25, 2023

Courtney Paget County of Glenn 225 North Tehama St Willows, CA 95988

Re: SPR2023-007

Anthony Agriculture Storage Building

Dear Courtney Paget,

Thank you for providing PG&E the opportunity to review the proposed plans for SPR2023-007 dated 9/20/2023. Our review indicates the proposed improvements do not appear to directly interfere with existing PG&E facilities or impact our easement rights.

Please note this is our preliminary review and PG&E reserves the right for additional future review as needed. This letter shall not in any way alter, modify, or terminate any provision of any existing easement rights. If there are subsequent modifications made to the design, we ask that you resubmit the plans to the email address listed below.

If the project requires PG&E gas or electrical service in the future, please continue to work with PG&E's Service Planning department: https://www.pge.com/cco/.

As a reminder, before any digging or excavation occurs, please contact Underground Service Alert (USA) by dialing 811 a minimum of 2 working days prior to commencing any work. This free and independent service will ensure that all existing underground utilities are identified and marked on-site.

If you have any questions regarding our response, please contact the PG&E Plan Review Team at pgeplanreview@pge.com.

Sincerely,

PG&E Plan Review Team Land Management



PUBLIC WORKS AGENCY

P.O. Box 1070 / 777 N. Colusa Street Willows, CA 95988 Airports
Engineering
Flood Control
Roads & Bridges
Solid Waste
Surveyor

Donald Rust, Director

September 28, 2023

Glenn County Planning and Community Development Services 225 N. Tehama Street Willows, CA 95988

Attn: Courtney Paget, Assistant Planner

Subject: Site Plan Review 2023-007 - Michael & Kristine Anthony

Comments

None

Conditions

None

Michael Biggs

Michael Biggs

Engineering Technician III Glenn County Public Works

GLENN COUNTY

Planning & Community Development Services Agency Environmental Health Department

225 N Tehama St. Willows, CA 95988

Tel: 530.934.6102 Fax: 530.934.6103

www.countyofglenn.net



Mardy Thomas, Director

Date: September 22, 2023

To: Courtney Paget, Assistant Planner

Planning & Community Development Services Agency (PCDSA)

(Via Email)

From: Kevin Backus, REHS

Director, PCDSA - Environmental Health Department

Re: Site Plan Review 2023-007, APN 044-150-015, Anthony (Ag Storage Building)

We have reviewed the application information for the project noted above and recommend it be found complete for further processing. We have the following comments/requirements:

- 1. The parcel has a water well, onsite wastewater treatment system and replacement area for the existing residences.
- 2. The proposed Ag storage building not approved for any wastewater discharge. Any future proposed wastewater discharge shall be approved under permit by the Environmental Health Department (EHD).

Please contact Environmental Health at 530-934-6102 with any questions on this matter.

September 22, 2023 Page 1

GLENN COUNTY Planning & Community Development Services Agency

225 North Tehama Street Willows, CA 95988 530.934.6540

www.countyofglenn.net



Mardy Thomas, Director

REQUEST FOR REVIEW

COUNTY DEPARTMENTS/DIST	TRICTS	STATE AGENCIES
⊠ Glenn County Agricultural Co ⊠ Glenn County Air Pollution Co ⊠ Glenn County Assessor ⊠ Glenn County Building Inspection ⊠ Glenn County Engineering & ⊠ Glenn County Environmenta ⊠ Glenn County Sheriff's Depation □ Glenn County Board of Supetion □ Glenn County Counsel □ Glenn County Planning Com	control District/CUPA ctor Surveying Division I Health Department rtment ervisors	 □ Central Valley Flood Protection Board □ Central Valley Regional Water Quality Control Board (RWQCB) □ State Water Resources Control Board – Division of Drinking Water □ Department of Alcoholic Beverage Control (ABC) □ Department of Conservation, Division of Land Resource Protection □ Department of Conservation, Office of Mine Reclamation (OMR) □ Dept. of Conservation, Division of Oil, Gas, and Geothermal Resources □ Department of Fish and Wildlife □ Department of Food and Agriculture □ Department of Forestry and Fire Protection (Cal Fire) □ Department of Housing and Community Development (HCD) □ Department of Public Health □ Department of Toxic Substances Control (DTSC)
FEDERAL AGENCIES U.S. Army Corps of Engineers U.S. Fish and Wildlife Service U.S. Department of Agriculture U.S. Bureau of Reclamation – Willows		 □ Department of Transportation (Caltrans) □ Department of Water Resources (DWR) □ Office of the State Fire Marshall □ CalRecycle
OTHER		
 Western Area Power Admini Sacramento River National V City of: Community Services District: Pacific Gas and Electric Com Fire Protection District: Orlar Glenn County Resource Cor School District: 	Vildlife Refuge : npany (PG&E) nd Rural	 NE Center of the CA Historical Resources Information System Railroad: Reclamation District: Water/Irrigation District: Special District: Tehama-Colusa Canal Authority UC Cooperative Extension Office
DATE:	September 20, 20	023
PROPOSAL:	Site Plan Review	2023-007, Anthony, Agriculture Storage Building
PLANNER:	Courtney Paget, A	

APPLICANT/ LANDOWNER:

Michael and Kristine Anthony

6329 County Road 7 Orland, CA, 95963

(530) 774-4840

Dmadrigal11@gmail.com

PROPOSAL:

Site Plan Review 2023-007, Agriculture Storage Building

An application for an agriculture storage building has been received. The exterior dimensions of the structure are 30 ft. by 60 ft. with a peak height of 15 ft. and an overall square footage of 1,800 square

feet.

LOCATION:

The project is located at 6329 County Road 7, north of County Road 9, west of Interstate 5, east of County Road FF, and south of County Road 7, in the unincorporated area of Glenn County, California.

APN:

044-150-015; (23.23± Acres)

ZONING:

"AE-20" (17-acre, minimum parcel size)

GENERAL PLAN:

"General Agriculture"

FLOOD ZONE:

The project site is located within Flood Zone "X." The property is located in both Flood Zone "X" and Flood Zone "A." Flood Zone "X" according to Flood Insurance Rate Map (FIRM) No. 06021C0165D, dated August 4, 2010 issued by the Federal Emergency Management Agency (FEMA). Flood Zone "X" is a flood zone area of minimal flood hazard, with a flood level above the 500-year flood, according to FIRMS. Additionally, "X" flood area is generally protected by levee form 100-year floods. Flood Zone "A" according to Flood Insurance Rate Map (FIRM) No. 06021C0165D, dated August 4, 2010 issued by the Federal Emergency Management Agency (FEMA). Flood Zone "A" (unshaded) consists of areas subject to inundation by the 1-percent-annual-chance flood event generally determined using approximate methodologies. Because detailed hydraulic analyses have not been performed, no Base Flood

elevations (BFEs) or flood depths are shown.

The Glenn County Planning Division is requesting comments on this proposal for determination of completeness, potential constraints, and/or proposed Compliance Requirement. If comments are not received by **Thursday**, **SEPTEMBER 28**, **2023**, it is assumed that there are no specific comments to be included in the analysis of the project. Comments submitted by e-mail are acceptable. Thank you for considering this matter.

AGENCY COMMENTS:

Please consider the following:

- 1. Is the information in the application complete enough to analyze impacts and conclude review?
- 2. Comments may include project-specific code requirements unique to the project. Cite code section and document (i.e., General Plan, Subdivision Map Act, etc.).
- 3. What are the recommended Compliance Requirements for this project and justification for each Requirement? When should each Compliance Requirement be accomplished (i.e., prior to any construction at the site, prior to recording the parcel map, filing the Final Map, or issuance of a Certificate of Occupancy, etc.)?

GLENN COUNTY PLANNING AND COMMUNITY **DEVELOPMENT SERVICES AGENCY**

225 North Tehama Street **Willows, CA 95988** (530) 934-6540

planning@countyofglenn.net

APPLICATION FOR SITE PLAN REVIEW

OTE:	FAILURE	TO	ANSWER	APPL

N ICABLE QUESTIONS AND REQUIRED ATTACHMENTS COULD DELAY THE PROCESSING OF YOUR APPLICATION. Applicant(s): Name: MICHAEL ANTHONY, KRISTINE ANTHONY

Address: 6329 COUNTY ROSO Phone: 530-774-4840E-Mail amadrigal 1100 mail COM

2. Property Owner(s): Name: MICHAEL ANTHONY, KRISTINE ANTHONY Address: 6329 COUNTY RD Phone: 530774-4840 E-Mail amadrigal 11 Egman 1. COM 3. Engineer/Person who Prepared Site Plan (if applicable):

Address:		
Phone:	E-Mail	
Name and addres	s of property owner's duly authorized agent (if ap hed with notice of hearing (§65091 California Gov	
who is to be furnis Code).	ned with hotice of hearing (80509). California Gov	011

4.

1.

Existing Use of Property: RE510	ENTIAL
	BOUNDINGS. THU
18 NOT B COMMERCIAL	BULDING
Address and Location of Project: 632	5 COUNTY ROAD of Drugo
Current Assessor's Parcel Number(s):	044-150-015-000
Existing Zoning (http://gis.gcppwa.net/	zoning/): AGRICULTURE
Provide any additional information that proposal. Example - number of employed deliveries/loadings per day:	
Setback Dimensions (Distance from pr	
North: 55 ft.	South: 655 ft.
East: <u>780</u> ft.	West: 580 ft.
Other Setback/s:ft.	
Provide the following information:	
Size of Assessor Parcel:	eaft 26 acres
	_sq.ftacres
Mean height of structure: 12_ft.	_sq.πacres Peak height of structure:ft.
Mean height of structure: 12 ft. Dimensions of proposed including ove	Peak height of structure: 15 ft.
	Peak height of structure:ft. rhangs: ft. xft.

DECLARATION UNDER PENALTY OF PERJURY

(Must be signed by Applicant(s) and Property Owner(s))
(Additional sheets may be necessary)

The Applicant(s) and/or Property Owner(s), by signing this application, shall be deemed to have agreed to defend, indemnify, release and hold harmless the County, its agents, officers, attorneys, employees, boards and commissions from any claim, action or proceeding brought against the foregoing individuals or entities, the purpose of which is to attack, set aside, void or null the approval of this development entitlement or approval or certification of the environmental document which accompanies it, or to obtain damages relating to such action(s). This indemnification agreement shall include, but not be limited to, damages, costs expenses, attorney fees or expert witness fees that may be asserted by any person or entity, including the applicant, arising out of or in connection with the approval of the entitlement whether or not there is concurrent passive or active negligence on the part of the County.

	Signed: Machel Squet
	Print: Michael Anthony
	Date: 09-08-2023
	Address: 6329 Goundy Rd 7 ORland CA. 95963
	I am (We are) the owner(s) of property involved in this application and I (We) have completed this application and all other documents required.
	I am (We are) the owner(s) of the property involved in this application and I (We) acknowledge the preparation and submission of this application.
	I (We) declare under penalty of perjury that the foregoing is true and correct.
7	Property Owner(s):
	Signed: Michael Smith + Kristine y Anthony
	Print: Michael Anthony & Kristine G. Anthony
	Date: 09-08-2023
	Address: 6329 County & 7 ORland CA 95963

Applicant(s):

CIOS ENCLOSED

2017-1891

Prepared By: Timios Title, A California Corporation 134 E. Walker St. Orland, CA 95963 No: 133449

Recorded at the request of: TIMIOS TITLE COMPANY 05/04/2017 03:10 PM Fee: \$23.00 Pgs: 4 OFFICIAL RECORDS Charles M. Meriam, Clerk-Recorder Glenn County, CA

After Recording Return And Mail Tax Statements To: MICHAEL ANTHONY KRISTINE ANTHONY

SPACE ABOVE THIS LINE FOR RECORDER'S USE A.P.N. NO. STATED BELOW

GRANT DEED

The undersigned grantor(s) declare(s):

City transfer tax is \$_

County Transfer Tax is \$0.00 RT CODE # 11911

Monument preservation fee is \$

(X) computed on full value of property conveyed, or

() computed on full value less value of liens and encumbrances remaining at time of sale.

(X) Unincorporated area: () City of ORLAND, and

FOR VALUABLE CONSIDERATION, receipt of which is hereby acknowledged, DAVID B. ANTHONY, TRUSTEE OF THE ANTHONY FAMILY TRUST DATED APRIL 21, 2009 hereby GRANTS to

MICHAEL ANTHONY AND KRISTINE ANTHONY, HUSBAND AND WIFE AS JOINT TENANTS

the following described real property in the unincorporated area, County of GLENN, State of California:

SEE EXHIBIT 'A' ATTACHED HERETO AND MADE A PART HEREOF

More commonly known as: Multiple Parcels in Orland, Orland California 95963

5/1/2017

THE ANTHONY FAMLY TRUST DATED APRIL 21, 2009

DAVID B ANTHONY, THE USE

A notary public or other officer completing this certificate verifies only the identity of the individual who signed the document to which this certificate is attached, and not the truthfulness, accuracy, or validity of that document.

							792
County of	CALIFORN GLENN					1 4	1
on W	ian 2"	20	17	, before me.	Olya	Valoroso	, a notary
public, pers the person(executed the the person(sonally appear whose nam- ie same in his/ s), or the entit der PENALT	ed DAVII e(1) is/are s ber/thou au y upon beh	B AN ubscrib thorize alf of w	THONY who pred to the within d capacity(ies), thich the person(instrument a instrument a and that by h (x) acted, exe	on the basis of satisfactor and acknowledged to me is/hor/their signature(1) cuted the instrument California that the foreg	on the instrumen
WITNESS	my hand and	official sea	L		0	OLGA VALC COMM. # 20 NOTARY PUBLIC- GLENN CO COMM. EXPIRES O	CALIFORNIA DO COUNTY O
Simple	SG Val	oroso				(Notary Seal)	

EXHIBIT "A"

LEGAL DESCRIPTION

PARCEL ONE:

PARCELS 1 AND 2 AS THE SAME ARE SHOWN ON PARCEL MAP NO. 2007-02, FILED FOR RECORD IN THE OFFICE OF THE COUNTY RECORDER OF THE COUNTY OF GLENN, STATE OF CALIFORNIA, ON SEPTEMBER 29, 2008 IN BOOK 13 OF PARCEL MAPS AT PAGE 53.

EXCEPTING THEREFROM ALL OIL, GAS AND MINERALS AND OTHER HYDROCARBON SUBSTANCES AS RESERVED IN THE DEED FROM BANK OF AMERICA NATIONAL TRUST AND SAVINGS ASSOCIATION TO WM. T. J. OWENS, ETUX, DATED APRIL 7, 1942 AND RECORDED MAY 6, 1942 IN BOOK 149 OF OFFICIAL RECORDS AT PAGE 113.

APNS: 044-150-015-9 AND 044-150-016-9

PARCEL TWO:

BEING THE NORTHWEST QUARTER OF THE NORTHWEST QUARTER AND THE WEST HALF OF THE NORTHEAST QUARTER OF SECTION 8, TOWNSHIP 22 NORTH, RANGE 3 WEST, M.D.M. AND THE SOUTH ONE-HALF OF LOT 16 AS SAID LOT IS SHOWN ON THAT CERTAIN MAP ENTITLED "MAP OF CALUMET TRACT" AND ON FILE AT THE OFFICE OF THE RECORDER OF SAID COUNTY OF GLENN IN BOOK 1 OF MAPS AND SURVEYS AT PAGE 69.

EXCEPTING THEREFROM FOR THEIR JOINT LIVES, A LIFE ESTATE IN AND TO ALL OIL, GAS, MINERALS AND OTHER HYDROCARBON ON SUBSTANCES LYING BELOW A DEPTH OF 500 FEET FROM THE SURFACE THEREOF, WITHOUT HOWEVER, THE RIGHT TO ENTER UPON SAID SURFACE FOR THE PURPOSE OF EXTRACTING THE SAME, AS RESERVED BY LOUISE J. RISLEY AND FLORA E. KEEN, IN THAT DEED RECORDED DECEMBER 27, 1990 AS GLENN COUNTY RECORDER'S INSTRUMENT NO. 90-6464.

NOTICE OF VOLUNTARY MERGER RECORDED AUGUST 20, 2004 AS GLENN COUNTY RECORDER'S INSTRUMENT NO. 2004-5301.

APN: 044-150-001-9; 044-150-002-9 & 044-090-019-9

PARCEL TWO A:

TOGETHER WITH AN EASEMENT FOR ROAD PURPOSES AND FOR PUBLIC UTILITY PURPOSES OVER A STRIP OF LAND 50.00 FEET IN WIDTH IN LOT 102, AS SAID LOT IS SHOWN ON THE MAP OF "ORLAND LAND COMPANY, MURDOCK SUBDIVISION", FILED IN THE OFFICE OF THE RECORDER OF SAID GLENN COUNTY, AND MORE PARTICULARLY DESCRIBED AS FOLLOWS:

BEGINNING AT THE NORTHEAST CORNER OF SAID LOT 102; THENCE ALONG THE NORTH LINE OF SAID LOT, SOUTH 89° 58' WEST, 1131.60 FEET; THENCE SOUTH 39° 13' WEST, 447.49 FEET TO THE CENTERLINE OF AN EXISTING ROAD EASEMENT; THENCE ALONG SAID CENTERLINE, SOUTH 36° 13' EAST, 51.62 FEET; THENCE NORTH 39° 13' EAST, 436.61 FEET TO A POINT 50.00 FEET SOUTH OF THE NORTH LINE OF SAID LOT 102; THENCE PARALLEL WITH THE NORTH LINE, NORTH 89° 58' EAST, 1108.46 FEET TO THE EAST LINE OF SAID LOT; THENCE ALONG SAID EAST LINE, NORTH 0° 42' WEST, 50.00 FEET TO THE POINT OF BEGINNING.

PARCEL THREE:

THE SOUTHEAST QUARTER OF THE SOUTHEAST QUARTER OF SECTION 6, TOWNSHIP 22 NORTH, RANGE 3 WEST, M.D.B.&M.

EXCEPTING THEREFROM ALL OIL, GAS AND MINERALS AND OTHER HYDROCARBON SUBSTANCES AS RESERVED IN THE DEED FROM BANK OF AMERICA NATIONAL TRUST AND SAVINGS ASSOCIATION TO WM. T. J. OWENS, ETUX, DATED APRIL 7, 1942 AND RECORDED MAY 5, 1942 IN BOOK 149 OF OFFICIAL RECORDS AT PAGE 113.

APN: 044-080-013-9



Civil Engineering and Design 3115 Johnny Ln, Chico, CA 95973 Ph: (530) 521-2648 eric@ausmusengineering.com

FOUNDATION & SOIL INVESTIGATION REPORT

July 31, 2023

Property Owner:

Michael Anthony 6239 County Road 7 Orland, CA 95963

Project Site:

6325 County Road 7 Orland, CA 95963





Civil Engineering and Design 3115 Johnny Ln, Chico, CA 95973 Ph: (530) 521-2648 eric@ausmusengineering.com

Purpose

The purpose of this study is to explore and evaluate the surface and subsurface soil conditions at the site and to develop information regarding the feasibility of this specific project. A seismic analysis will also be performed whose minimum values will be used by the structural designer.

Scope

- 1. Review of geologic and topographic data available to Ausmus Engineering at the time of the study
- 2. Field study consisting of a visual site reconnaissance, followed by an exploratory test pit to characterize the subsurface conditions
- 3. Comparison of visual site characteristics with the soil properties given by the United States Department of Agriculture, Natural Resource Conservation Service database
- 4. Site analysis for potential hazards including, flooding, liquefaction, landslides, high water table and expansive soils
- 5. Preparation of this report summarizing the findings and conclusions.

Important Notes

Always notify Ausmus Engineering whenever the scope of the project has changed in order to request an assessment of its impact. Ausmus Engineering cannot accept responsibility or liability for problems that occur due to changes in scope.

The findings of this report are valid as of the date this report was created. Changes in the conditions of a property can occur over the passage of time, typically from the works and also from natural processes. Changes to the site outside of the control of Ausmus Engineering may cause the findings in this report to become invalid, wholly or partially. Therefore, this report should not be relied on after a period of three years without our review.





Civil Engineering and Design 3115 Johnny Ln, Chico, CA 95973 Ph: (530) 521-2648 eric@ausmusengineering.com







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Introduction

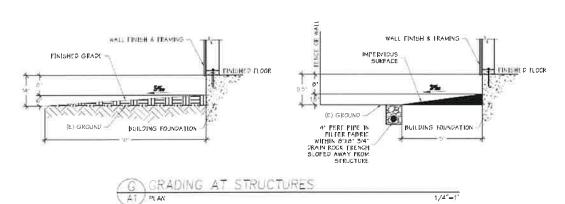
Based on a site visit on July 20, 2023, the project will consist of a new timber-framed shop with metal siding and roofing. The foundation will be constructed using a reinforced concrete slab on grade foundation with a perimeter footing. The use of the proposed structure will be for storage.

Topography

The proposed structure will be located in the northern California valley, and 1 miles to the north of the City of Orland. The site is surrounded by agricultural fields. The area has been flagged by the County as having potential expansive clays.

Local Drainage

The structure will be constructed to drain the surface runoff away from the project site. According to FEMA's web map the site is located in zone 06021C0165D and is in flood zone A, which is in a special flood hazard area, having a 1% annual chance of flooding and a 26% chance of flooding over the life of a 30-year mortgage. Grading at the structure will follow figure G/A1 below.





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Soil Properties from USDA Web Soil Survey:

Liquid Limit: 25 Plastic Index: 2.5

AASHTO Classification: Czk-Cortina gravelly fine sandy loam rating: A-2

Linear Extensibility: 1.5

Soil Expansion Potential

The soil's expansion potential is typically measured by Linear Extensibility which is an expression of the volume difference of natural soil fabric at 1/3-bar or 1/10-bar water content and oven dryness. The volume change is reported as percent change for the whole soil. Linear extensibility is used to determine the shrink-swell potential of soils. The shrink-swell potential is low if the soil has a linear extensibility of less than 3 percent; moderate if 3 to 6 percent; high if 6 to 9 percent; and very high if more than 9 percent. If the linear extensibility is more than 3, shrinking and swelling can cause damage to buildings, roads, and other structures and to plant roots.

The soil encountered during the site visit and investigation is considered to have low shrink-swell potential since the linear extensibility falls below 3 percent.

Excavation, Grading and Fill

Because this site has been identified as having low expansive soils, management of water adjacent to the building is not extremely critical, but is still important.




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Remove the top 4" of soil. Excavation for the perimeter footing shall extend a minimum of 12" below undisturbed ground. The site shall be graded away from the building according to detail G/A1 at a slope of not less than 5% for a minimum distance of 10 feet from a distance measured perpendicular from the wall or edge of slab. If 10' cannot be achieved, 5' minimum shall be maintained with the incorporation of a swale diverting flows away from the structure at a minimum 2% grade.

Foundation Footing Design

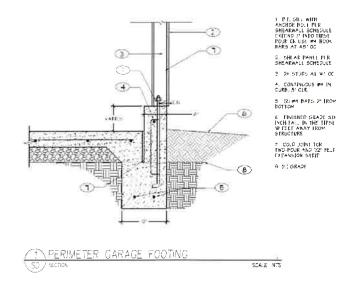No fill dirt shall be used in depths of 12" or greater without obtaining a compaction test provided by a licensed professional. Provided minimum (2) #4 bars evenly spaced 3" from bottom of footing as shown on detail 1/SD.



Slab Design

According the California residential code, all slabs used for the parking of vehicles shall be sloped for the purpose of conveying liquids. Concrete slab foundation will be used during construction with perimeter concrete footings, as shown in detail 2/SD. Even though the garage space is unconditioned, the vapor barrier will still be necessary to prevent moisture-loss under the slab exacerbating the extremes of the shrink-swell cycle. The concrete mix, reinforcing, joint locations, moisture protection and underlayment are under the purview of the structural designer and will be shown on the approved foundation plan and details. Commercial vehicles may be expected on a portion of the slab. A minimum slab thickness of 4" shall be maintained with troweled or wet-sawn crack control joints spaced at 10' in each direction. Half-inch (½") Felt shall be used around the perimeter of the slab and expansion joints shall be spaced every 3 joints



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when floating slabs need to be separated from foundations. A 4" slab may be used at non-vehicle locations.

Moisture protection shall be provided by the incorporation of a 6 mil (minimum) vapor barrier and constructed in the manner depicted in detail 2/SD.

Please note that moisture protection does not construe waterproofing. If water proofing design is required, an expert should be consulted with. The 1" moist sand underlayment may be omitted if the concrete is sprayed with a curing compound.

All concrete should be expected to crack. Therefore, the minimums prescribed here should not be a stand-alone design to address crack control and should be used as a supplemental to the design methodology.

The reinforcing shall be as directed by the structural designer. Deformed #3 reinforcing bars spaced a maximum of 18" on center or #4 bars at 24" on center in each direction placed in the center of the slab section will provide the most beneficial design to resist slab cracking. The use of 6"x6"-10/10 welded wire fabric can also be effective if installed correctly, according to the manufacturer's recommendations. However, engineering experience has always deemed the use of deformed bars as a superior alternative.



3. 4" MIN OF W2 TO 34" CLEAN AGGREGATE

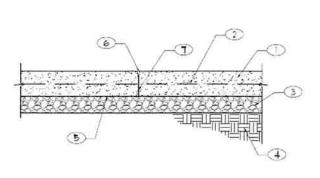
4. UNDISTURBED NATURAL GROUND OR ENGINEERED FILL PER FOUNDATION NOTE #2 ON SHEET SS

5. 6 MIL VAPOR BARRIER CR EQUAL PIRECTLY UNDER CONSRETE W/6* MIN LAPPED JOINES

6 VOIXI/SEP OF CONCRETE PEPFH DEEP SAWOUT (FILL WITH CAULKING)

WHERE OCCURS

NOTE: ALSO APPLIED TO ATTACHED GARAGES





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Exterior Flatwork

Exterior concrete flatwork need not be underlain by rock but shall be separated from structure foundations by a felt expansion strips and vapor barrier.

Seismicity

Glenn County is located in a seismic hazard zone as identified by the Seismic Hazards Mapping Program of the California Geological Survey, since the entire County is subject to earthquakes of Modified Mercalli Intensity scale VIII. The potential for this site to experience mild to moderate shaking in the future can be expected.

Liquefaction

Liquefaction, which may occur under strong ground shaking during earthquakes, is the transformation of granular sediment or fill material from a solid state to a temporarily liquid state. Areas paralleling the Sacramento River that contain clean sand layers with low relative densities are estimated to have generally high liquefaction potential. Clean layers of granular materials older than Holocene are of higher relative densities and are thus of low liquefaction potential. Due to this site's soil type, there is low potential for liquefaction.

Allowable Bearing Values

Allowable soil bearing pressures shall conform to section 1804 of the California Building Code. The allowable foundation pressure shall not exceed 1,500 psf and may be increased by 1/3 when using load combinations that include wind and seismic. Lateral sliding resistance shall not exceed 130 psf except may be increased by 100 psf for each additional foot of depth to a maximum of 1500 psf.

Recommendations

Based upon the results of the field explorations and analysis, it is Ausmus Engineering's opinion that construction of the proposed project is feasible. The contractor/builder shall conform to all minimum requirements stated in this report as well as the engineered plans and all relevant provisions from the California Building Code, and all local, state, and federal codes and regulations.


Summary

Hazard Description:	Potential
Water table	>78"
Expansive soil	Low
Liquefaction:	Low
Landslide	No Potential
Flood Hazard	High
Expected Differential Settlement	Total <2" with 1" differential depending on drainage
Allowable Soil Pressure	1500 w/ 1/3 increase w/ load combos



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APPENDIX

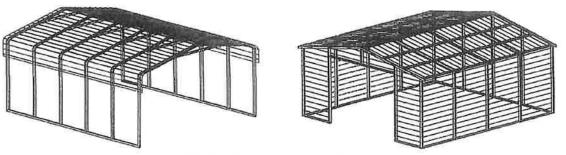

REGULAR / A-FRAME 30'-0" WIDE

CARPORT STYLE BUILDINGS

DESIGN NOTES

OWNER:

ADDRESS:

- 1. ALL CONSTRUCTION SHALL BE PROVIDED IN ACCORDANCE WITH PREVAILING CODE: IBC 2021, OSHA, AISC 360, AISI 100, ASCE 7-16, AWS DI.3 CODES AND ALL APPLICABLE LOCAL REQUIREMENTS.
- 2. ALL MATERIALS IDENTIFIED BY MANUFACTURER NAME MAY BE 1. ROOF DEAD LOAD (D) SUBSTITUTED WITH MATERIAL EQUAL OR EXCEEDING ORIGINAL. 2. ROOF LIVE/SNOW LOAD (Lr)
- 3. ALL SHOP CONNECTIONS SHALL BE WELDED CONNECTIONS.
- 4. ALL STRUCTURAL FIELD CONNECTIONS SHALL BE #12-14 X 3 41 SDS (ESR-2196 OR EQ) WITHOUT WASHERS.
- 5. STEEL SHEATHING SHALL BE 29GA CORRUGATED GALV. OR PAINTED STEEL - MAIN RIB HT. 3/4" (FY=80KSI) OR EQ. CONNECTIONS SHALL BE #12-14 X 3/1 SDS (ESR-2196 OR EQ) WITH NEOPRENE WASHERS.
- 6. ALL STRUCTURAL LIGHT GAUGE TUBING AND CHANNELS SHALL BE GRADE 50 STEEL (FY = 50 KSI, FU = 65 KSI).
- 7. STRUCTURAL TUBE 2 1/2" X 2 1/2" 14 GA IS EQUIVALENT TO TS 2 7" X 2 1/4" - 12GA AND EITHER ONE MAY BE USED IN LIEU OF THE
- B. GYPSUM BOARD OR DRYWALL FINISH OR ANY BRITTLE BASE MATERIAL IS NOT ACCOUNTED FOR IN THE DESIGN CRITERIA.
- 9. ALL DESIGN CRITERIA MUST BE INCREASED TO THE NEXT HIGHER INCREMENT BASED ON THE TABLES ON PAGE 4. NO INTERPOLATION IS ALLOWED.

DESIGN CRITERIA

USE GROUP: RISK CATEGORY:

3. SNOW LOAD (S) GROUND SNOW LOAD IMPORTANCE FACTOR THERMAL FACTOR EXPOSURE FACTOR ROOF SLOPE FACTOR

4. WIND LOAD (W) BASIC WIND SPEED EXPOSURE

5. SEISMIC LOAD (E) DESIGN CATEGORY IMPORTANCE FACTOR

LOAD COMBINATIONS:

- D + (Lr OR 5) D + (0.6W OR ±0.7E)
- D + 0.75 (0.6W OR ±0.7E) + 0.75 (Lr OR S)
- 0.6D + (0.6W OR ±0.7E)

DRAWING INDEX

COVER SHEET

SCHEDULES & MEMBER -**SECTIONS** FRAME SECTIONS & DETAILS ----

SPACING SCHEDULES -& ENCLOSURE NOTES PURLIN & GIRT SCHEDULES

SHEATHING OPTIONS SIDE WALL FRAMING

& OPENING5 7-A, 7-B END WALL FRAMING

& OPENINGS 8-A, 8-B CORNER BRACING DETAILS OPTIONAL LEAN-TO ADDITION 10

FOUNDATION OPTIONS ---- 11-A TO 11-D

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2

3

4

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6

MANUFACTURED BY



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DRAWING INFORMATION

PROJECT: 30'-0" WIDE BUILDINGS

LOCATION: STATE OF CALIFORNIA

PROJECT NO: 233-23-0049 SHEET TITLE:

COVER SHEET

1/11 SHEET NO .:

DRAWN BY: A.W. DATE: 2/2/22 DATE: 2/2/22

CHECKED BY: OAA

LEGAL INFORMATION

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SEAL:



STAMP EXPIRY: 12-31-2024 DATE SIGNED: 01-13-2023

CUSTOMER INFORMATION **DESIGN LOADS BUILDING INFORMATION** FRAME TYPE: GROUND SNOW: WIDTH:

BASIC WIND SPEED:

ROOF LIVE LOAD: LENGTH:

ENCLOSURE HEIGHT:

CBC 2022 (IBC 2021)

D = 4 PSF

15 = 0.8

Ct = 1.2

Ce = 1.0

 $C_5 = 1.0$

1e = 1.00

Lr = 20 - 61 PSF

SEE TABLE 4)

(AS PER SNOW LOAD

Pa = 20 - 90 P5F

YULT = 105 - 180 MPH

U (CARPORTS, BARNS)

☐ A-FRAME ☐ REGULAR I FULL II PARTIAL

OPEN

DATE OF PLANS 01-13-2024 CERTIFICATION ON THESE DRAWINGS IS VALID FOR ONE YEAR FROM DATE OF ISSUE

CERTIFICATION VALIDITY NOTICE

TABLE 2.1: MEMBER PROPERTIES


0.51		E 2.1: MEMBER PROPERTIES	DETAIL NO
10)	LABEL	PROPERTY	DETAIL NO.
1	COLUMN POST	2.5" X 2.5" X 14GA TUBE W/ 2.25" X 2.25" X 12GA TUBE INSERT	11
2	ROOF BEAM	2.5" X 2.5" X 14GA TUBE	1
3	BASE RAIL	2.5" X 2.5" X 14GA TUBE	1
4	PEAK BRACE	2.5" X 2.5" X 14GA TUBE	1
5	KNEE BRACES	2.5" X 1.5" 14GA CHANNEL	4
6	CONNECTOR SLEEVE	2.25" X 2.25" X 12GA TUBE	2
7	BASE ANGLE	2" X 2" X 3" LG. 3/16" ANGLE	10
В	PURLIN	4.25" X 1.5" X 18GA / 14GA HAT CHANNEL	5
9	GIRT	4.25" X 1.5" X 18GA / 14GA HAT CHANNEL	5
10	SHEATHING	29 GA CORRUGATED SHEET	В
11	END WALL POST	2.5" X 2.5" X 14GA TUBE	1
12	DOOR POST	2.5" X 2.5" X 14GA TUBE	1
13	5INGLE HEADER	2.5" X 2.5" X 14G∧ TUBE	1
14	DOUBLE HEADER	DBL. 2.5" X 2.5" X 14GA TUBE	1
15	SERVICE DOOR / WINDOW FRAMING	2.5" X 2.5" X 14GA TUBE	1
16	ANGLE BRACKET	2" X 2" X 2" L.G. 14GA ANGLE	7
17	STRAIGHT BRACKET	2" X 2" X 4" LG. 14GA PLATE	6
18	PB SUPPORT	2.5" X 2.5" X 14GA TUBE	1
19	DIAGONAL BRACE	2" X 2" X 14 GA TUBE	3
20	GABLE BRACE	2" X 2" X 14 GA TUBE	3
21	DB BRACKET	2.25" X 2.25 X 6" X 14GA ANGLE	9
22	TRUSS SPACER	2.5" X 2.5" X 14GA TUBE	1
23	ALL FASTENERS	#12 X 1" SELF-DRILL SCREWS (ESR-2196 OR EQ) W/ NEOPRENE/STEEL WASHER	

TABLE 2.2: SHEATHING FASTENER SCHEDULE

LOCATION	CORNER PANELS	SIDE LAPS	EDGE LAPS	ELSEWHERE
SPACING	9' C/C	MIN.1	4½" C/C	9" C/C

FASTENER TYPE: #12X1" SELF-DRILL SCREWS (ESR-2196 OR EQ) W/ NEOPRENE/STEEL WASHER

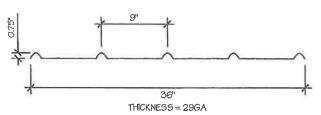
"SEE TYP, SHEATHING FASTENER SCHEDULE DIAGRAM ON PAGE 6.



29 GA CORRUGATED SHEATHING B




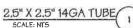THICKNESS = 14GA





THICKNESS = 12GA

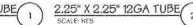




THICKNESS = 14GA

2" X 2" 14GA TUBE 3



THICKNESS = 14GA

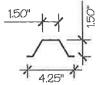2.5" X 1.5" 14GA CHANNEL



THICKNESS = 14GA / 18GA

4.25" X 1.5" X 18GA / 14GA HAT CHANNEL

SCALE: NTS



2.5" X 2.5" X 14GA TUBE W/ 2.25" X 2.25" X 12GA TUBE INSERT

SCALE: NTS
NOTE: INSERT FULL LENGTH & FIELD
BOLT W/ [23] FASTENERS @ 12" C/C
STAGGERED OPPOSITE FACE



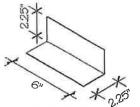
THICKNESS = 14GA

STRAIGHT BRACKET



THICKNESS = 14GA

ANGLE BRACKET 7



THICKNESS = 14GA

DB BRACKET 9



THICKNESS = 3/16"

BASE ANGLE 10



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DRAWING INFORMATION

PROJECT: 30'-0" WIDE BUILDINGS

LOCATION: STATE OF CALIFORNIA

PROJECT NO.: 233-23-0049

SHEET TITLE:

SCHEDULES & MEMBER SECTIONS

SHEET NO.: 2 / 11

DRAWN BY: A.W. DATE: 2/2/22

CHECKED BY: OAA

DATE: 2/2/22

LEGAL INFORMATION


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DRAWING INFORMATION

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LOCATION: STATE OF CALIFORNIA

PROJECT NO.: 233-23-0049

SHEET TITLE:

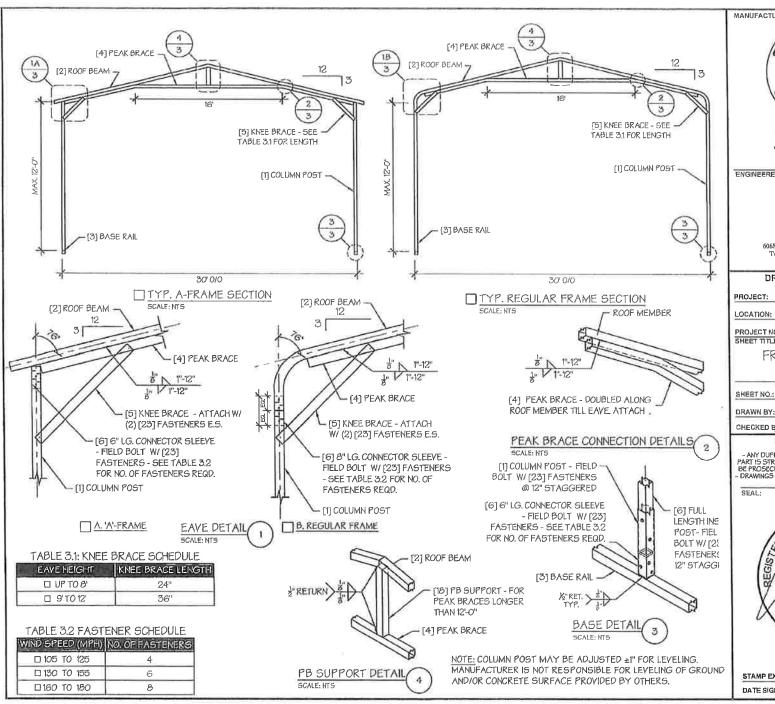FRAME SECTIONS & DETAILS

3 / 11

DRAWN BY: A.W. DATE: 2/2/22

CHECKED BY: OAA

DATE: 2/2/22

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STAMP EXPIRY: 12-31-2024

DATE SIGNED: 01-13-2023

TABLE 4: FRAME SPACING CHART / SCHEDULE

	GROUND SNOW /			■ ENCLO	SED BUIL	DINGS				(C (A)	□ OPE	N BUILDIN	NGS		E STATE
	ROOF LIYE			WIND	SPEED (N	APH)					WIND	SPEED (N	ЛРН)		
	LOAD (PSF)	□105	□ 115	□130	□140	□155	□165	□18O	□105	□ 115	□13O	140	□155	□165	 □180
	30/20	60	60	54/60	54	48	42/48	36/42	54	48/54	42/48	42	36/42	36	30
HEIGHT = TO 12:-0"	40/27	48/60	48/60	42/60	42/54	48	42/48	36/42	48	48	42/48	42	36/42	36	30
유현	□50 <i>l</i> 34	40/48	40/48	40/48	40/48	40/48	40/48	36/42	40/42	40/42	40/42	40/42	36	36	30
무	□ 60 / 41	36/42	36/42	36	36	36	36	36	36	36	30	30	30	30	24
EAVE 10:0'	□70 / 47	32/36	32/36	32/36	32/36	30	30	30	30	30	30	24	24	24	24
\$ Q	□80/54	24	24	24	24	24	24	24	24	24	24	24	24	24	
	90/61	18	18	18	18	***	455	***	18	18		1000	***	***	
	□30/20	60	60	54/60	54	48	42/48	36/42	54	48/54	42/54	42/48	36/42	36/42	30/36
ان ا	□ 40 <i>l</i> 27	48/60	48/60	42/60	48/54	48	42/48	36/42	48	48	42/48	42/48	36/42	36/42	30/36
GHT = 9-0	□50/34	40/54	40/54	40/54	40/48	40/48	40/48	36/42	40/42	40/42	40/42	40/42	36/42	36	30/36
무은	□ 60 / 41	36/48	36/42	36/42	36/42	36/42	36/42	36/42	36	36	36	36	36	36	30/36
EAVE	□70/47	32/36	32/36	32/36	32/36	32/36	30	30	30	30	30	30	30	30	24
m i	□80/54	30	30	30	30	30	30	30	24	24	24	24	24	24	24
T.D.	<u> 90/61</u>	24	24	24	24	24	24	24	18	18	18	18	18	18	18
	□30/20	60	60	54/60	54	48	42/48	36/42	54	48/54	42/54	42/54	36/48	36/48	30/36
 ⊨ ਨ	□ 40 / 27	48/60	48/60	42/60	42/54	42/48	42/48	36/42	48	4B	42/48	42/48	36/48	36/48	30/36
0.0 0.0	□50/34	40/54	40/54	40/54	40/48	40/48	40/48	36/42	40/42	40/42	40/42	40/42	36/42	36/42	30/36
무이	☐ 60 / 41	36/48	36/48	36/48	36/48	36/42	36/42	36/42	36	36	36	36	36	36	30/36
EAVE HEIG UP TO 6	□70/47	32/42	32/42	32/36	32/36	32/36	32/36	30	32/36	32/36	30	30	30	30	24
	□80/54	30/36	30/36	30/36	30/36	30/36	30	30	30	30	30	30	30	24	24
	□ 90 / 61	30/36	30/36	30	30	30	30	30	24	24	24	24		1414.0	

NOTES:

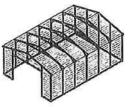
- . FRAME SPACINGS ARE IN UNITS OF INCHES (IN).
- 2. WHERE TWO VALUES ARE SHOWN, THE HIGHER VALUE CAN ONLY BE USED FOR VERTICAL SHEATHING.
- 3. SNOW LOADS AND ROOF LIVE LOADS ARE IN POUNDS PER SQUARE FOOT (PSF), WIND SPEED IS 3 SEC. GUST IN MILES PER HOUR (MPH).
- 4. FOR VALUES THAT LIE BETWEEN TWO CELLS, THE HIGHER (MORE STRINGENT) VALUE HAS TO BE USED. INTERPOLATION BETWEEN CELLS IS NOT ALLOWED.

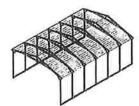
ENCLOSURE CLASSIFICATION:

- 1. ENCLOSED BUILDING = ALL 4 WALLS FULLY ENCLOSED WITH DOORS/WINDOWS = USE ENCLOSED BUILDING SPACING CHART.
- 2. OPEN BUILDING = ALL 4 WALLS FULLY OPEN = USE OPEN BUILDING SPACING CHART.
- 3. 3FT PARTIALLY ENCLOSED = BOTH END-WALLS FULLY OPEN, WITH BOTH SIDE-WALLS ONLY 3FT ENCLOSED = USE OPEN BUILDING SPACING CHART.
- 4. PARTIALLY ENCLOSED = BOTH END-WALLS FULLY OPEN, WITH BOTH SIDE-WALLS ENCLOSED MORE THAN 3FT = START WITH OPEN BUILDING SPACING CHART AND THEN REDUCE SPACING BY 6".
- 5. 3 SIDED ENCLOSED = ALL WALLS ARE ENCLOSED EXCEPT FOR 1 END-WALL = START WITH ENCLOSED BUILDING SPACING + THE OPEN END FRAME MUST HAVE EITHER A GABLED END OR HAVE DOUBLED WELDED LEGS & ROOF.
- FOR ALL SHEATHING ENCLOSURES NOT LISTED ABOVE, REFER TO SHEET 5 FOR SPACING AND DESIGN REQUIREMENTS.

GENERAL NOTES:


- THE MAX, BUILDING LENGTH FOR ENCLOSED BUILDINGS IS 50'-0". THIS CAN BE INCREASED BY ADDING A DOUBLE FRAME AT THE CENTER TO BREAK THE LENGTH OF THE BUILDING.
- 2. BUILDINGS WITH <u>PARTIALLY ENCLOSED END WALLS</u> NEED TO HAVE SIDE WALL BRACING TO SUPPORT THE PARTIALLY ENCLOSED END WALL, (SEE FIGURE A ON SHEET 5).





TYP. ENCLOSED BUILDING

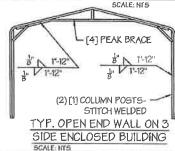TYP. OPEN BUILDING





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SPACING SCHEDULES & ENCLOSURE NOTES

SHEET NO .:

WN BY: A.W. DATE: 2/2/22

DRAWN BY: A.W.

CHECKED BY: OAA DATE: 2/2/22

4/11

LEGAL INFORMATION

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SEA1:

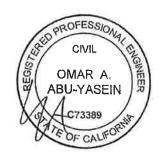


TABLE 5.1: PURLIN SPACING SCHEDULE

	GROUND SNOW /	■ 14GA HAT CHANNEL PURLIN						
	ROOF LIVE	WIND SPEED (MPH)						
	LOAD (PSF)	105	115	130	140	155	165	180
35.	□30/20	54	48	42	36	30	24	24
ACING	□ 40 / 27	42	42	42	36	30	24	24
¥ .	□50/34	40	40	40	36	30	24	24
E 57 5-0	□ 60 / 41	36	36	36	36	30	24	24
FRAWE SF ■ 5-0	□ 70 / 47	32	32	32	32	30	24	24
₹,	□ <i>8</i> 0/54	30	30	30	30	30	24	24
	□ 90 / 61	24	24	24	24	24	24	24
di	□30/20	54	48	42	42	36	30	30
ÖNÖ	□ 40 <i>l</i> 27	42	42	42	42	36	30	30
× 10	□50/34	40	40	40	40	36	30	30
(S)	0 60 / 41	36	36	36	36	36	30	30
FRAME SI ■ 4'-6	□ 70 <i>I</i> 47	32	32	32	32	32	30	30
₩.	□ <i>8</i> 0/54	32	32	32	32	32	30	30
	<u> 90/61</u>	30	30	30	30	30	30	30
Ö	D30/20	54	48	42	42	36	36	30
3	□ 40 / 27	42	42	42	42	36	36	30
¥ .	□50/34	40	40	40	40	36	36	30
E 5.	0 60 / 41	36	36	36	36	36	36	30
置	0 70 / 47	32	32	32	32	32	32	30
FRAME SPA ■ 4:0:	□ 80 / 54	32	32	32	32	32	32	30
	D 90 / 61	30	30	30	30	30	30	30
ėš –	□30/20	54	48	42	42	36	36	30
Ž	D 40 / 27	42	42	42	42	36	36	30
FRAME SPACING: 5-6"	□50/34	40	40	40	40	36	36	30
0 D	□ 60 / 41	36	36	36	36	36	36	30
ΣD	□ 70 / 4 7	32	32	32	32	32	32	30
S.	□ 80 / 54	32	32	32	32	32	32	30
	<u> 90 / 61</u>	30	30	30	30	30	30	30
Öw	□30120	54	48	42	42	36	36	30
ESITE	D 40 / 27	42	42	42	42	36	36	30
2.AC	□ 50 / 34	40	40	40	40	36	36	30
ES. 1	□ 60 / 41	36	36	36	36	36	36	30
₩, 9	D 70 / 47	32	32	32	32	32	32	30
e io	□ 80 / 54	32	32	32	32	32	32	30
	□ 90 / 61	30	30	30	30	30	30	30

NOTES:

- 1. PURLIN SPACING UNITS ARE IN INCHES.
- 2. FRAME SPACING NEEDS TO BE DETERMINED FROM TABLE 4.

RREGULAR BUILDING NOTES:


- 1. FIGURES A, B, C & D ON THE RIGHT INDICATE EXAMPLES OF IRREGULAR BUILDINGS.
- 2. FOR IRREGULAR BUILDINGS, FRAME SPACING MUST BE REDUCED BY 6" FROM <u>OPEN BUILDING</u> SPACING TABLE. SEE SHEET 4 FOR OPEN BUILDING TABLE.
- 3. SITE SPECIFICS MAY ALLOW FOR ALTERNATIVE SPACING.

TABLE 5.2: GIRT SPACING SCHEDULE

FRAME	WIND SPEED (MPH)						
SPACING	105	115	130	140	155	165	180
□5'-O"	60	48	36	30	24	24	18
□4'-6"	60	60	48	42	36	30	24
□4'-0"	60	60	54	54	42	36	30
□3'-6"	60	60	54	54	48	42	42
□2'-0' TO 3'-0''	60	60	54	54	48	42	42

NOTES:

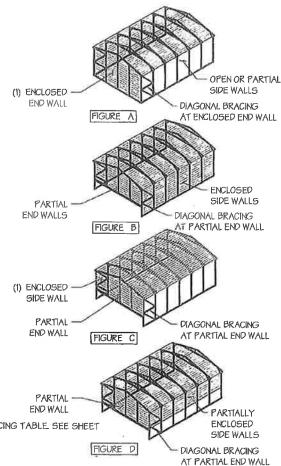- 1. GIRT SPACING UNITS ARE IN INCHES.
- 2. THIS SCHEDULE IS TO BE USED FOR BOTH
- FRAME SPACING NEEDS TO BE DETERMINED FROM TABLE 4.





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CIVIL STRUCTURAL

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DRAWING INFORMATION

PROJECT: 30'-0" WIDE BUILDINGS

LOCATION: STATE OF CALIFORNIA

PROJECT NO.: 233-23-0049

PURLIN & GIRT SPACING SCHEDULES

SHEET NO.: 5 / 11

DRAWN BY: A.W. DATE: 2/2/22

CHECKED BY: OAA

DATE: 2/2/22

LEGAL INFORMATION


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SEAL:



STAMP EXPIRY: 12-31-2024

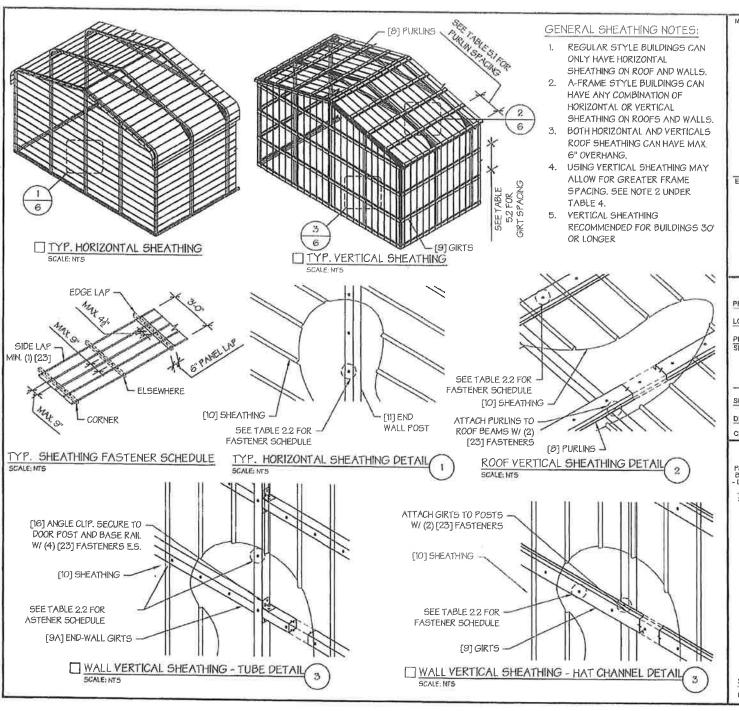DATE SIGNED: 01-13-2023







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ENGINEERED BY:



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CIVIL • STRUCTURAL
6063 Renaissance Place, Toledo, OH 43623
Tel. 419:29241945
www.as-engineers.com

DRAWING INFORMATION

PROJECT: 30'-0" WIDE BUILDINGS

LOCATION: STATE OF CALIFORNIA

PROJECT NO.: 233-23-0049

SHEET TITLE:

SHEATHING OPTIONS & DETAILS

SHEET NO :

6/11

DRAWN BY: A.W.

CHECKED BY: OAA

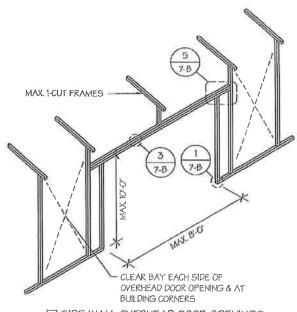
DATE: 2/2/22

LEGAL INFORMATION

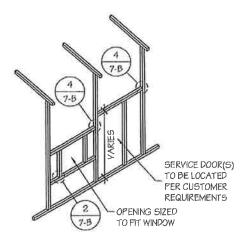
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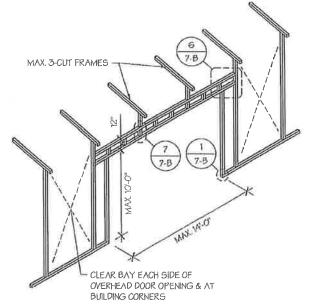




SIDE WALL OVERHEAD DOOR OPENINGS SCALE: NT5



SIDE WALL SERVICE DOOR / WINDOW OPENINGS SCALE: NT5



SIDE WALL OVERHEAD DOOR OPENINGS WITH TRUSS STYLE HEADER SCALE: NTS

SIDE WALL FRAMING NOTES:

- 1. TRUSS-STYLE HEADERS ARE REQUIRED FOR WHERE THE GROUND SNOW LOAD IS 40 PSF OR GREATER.
- 2. DESIGNS AND DETAILS SHOWN HERE ARE APPLICABLE TO BOTH REGULAR AND A-FRAME STYLE BUILDINGS.
- 3. MAX. HEIGHT OF SIDE WALL OVERHEAD DOOR OPENINGS IS 2 FT LESS THAN THE EAVE HEIGHT.
- 4. OVERHEAD DOOR OPENINGS CANNOT CUT THROUGH MORE THAN 2 FULL FRAMES.
- 5. MIN. 1 CLEAR BAY MUST BE MAINTAINED BETWEEN ANY 2 OVERHEAD DOOR OPENINGS. A CLEAR BAY IS A SPACE BETWEEN TWO FRAMES THAT HAS NO OVERHEAD DOOR OPENINGS.
- 6. MIN. 1 CLEAR BAY MUST ALSO BE MAINTAINED FROM THE BUILDING CORNERS.
- 7. SERVICE DOORS AND WINDOWS CAN BE PLACED IN CLEAR BAYS OR ANY WHERE ELSE AS NEEDED.



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DRAWING INFORMATION

PROJECT: 30'-0" WIDE BUILDINGS

LOCATION: STATE OF CALIFORNIA

PROJECT NO.: 233-23-0049

SHEET TITLE:

SIDE WALL FRAMING & OPENINGS

7-A / 11 SHEET NO .:

DRAWN BY: A.W.

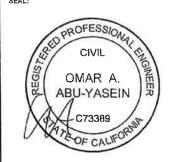
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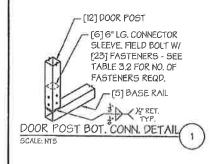
CHECKED BY: OAA DATE: 2/2/22

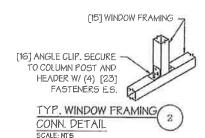
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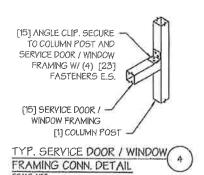
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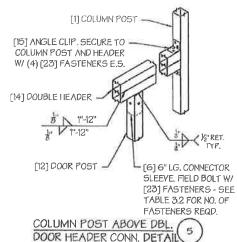
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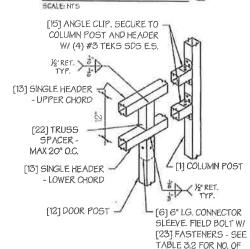












COLUMN POST ABOVE DBL

DOOR HEADER CONN. DETAIL

[1] COLUMN POST

1/2" RET.

TYP.

ABOVE HEADER

[6] 6" LG. CONNECTOR

SLEEVE, FIELD BOLT W/

[23] FASTENERS - SEE


TABLE 3.2 FOR NO. OF


- [14] DOUBLE HEADER

FASTENERS REQU



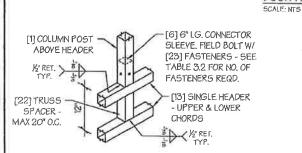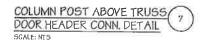FASTENERS REQD.









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	END WALLS DO NOT REQUIRE GABLE BRACING.	TEND WALL SERVICE DOOR AND WINDOW OPENINGS	WIND SPEED		AVE HEIGH	
l	SAULE DANGING.	SCALE; NTS	(MPH)	UP 107	■ 8'TO 9'	■10' TO 12'
EN	ID WALL FRAMING NOTES:		□ 105	5'	5"	5'
1.	DESIGNS AND DETAILS SHOWN HE	RE ARE APPLICABLE TO BOTH REGULAR AND A-FRAME STYLE BUILDINGS.	□ 1 1 5	5'	5'	4.5'
2.		NTAINED BETWEEN ANY TWO OPENINGS (OVERHEAD DOOR OR SERVICE DOOR)	□ 13 <i>0</i>	4.5'	4.5'	4'
١.	AND FROM CORNERS.		□ 140	4.5'	4.5'	3"
3.	SERVICE DOORS AND WINDOWS CA		15 5	40	4'	2.5'
4.	BRACE CONNECTION DETAILS.	DDED FOR PARTIAL END WALL ENCLOSURES. SEE SHEET 9 FOR DIAGONAL	□ 165 - 18O	3.5'	3'	2'



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DRAWING INFORMATION

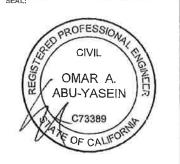PROJECT; 30'-O" WIDE BUILDINGS

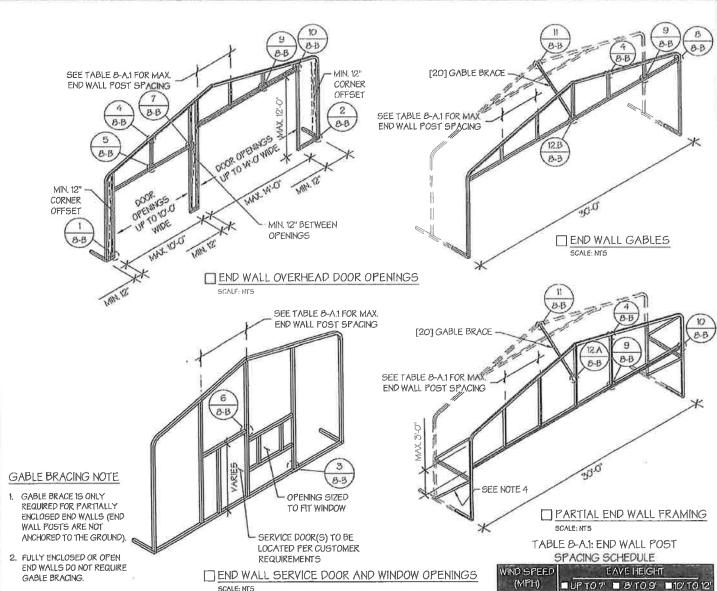LOCATION: STATE OF CALIFORNIA

PROJECT NO.: 233-23-0049

SHEET TITLE:

END WALL FRAMING

8-A / 11 SHEET NO:

DRAWN BY: A.W. DATE: 2/2/22


CHECKED BY: OAA

DATE: 2/2/22


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SEAL:



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CONCRETE SLAB FOUNDATION NOTES:

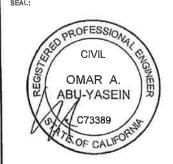- 1. DESIGNS SHOWN ON THIS SHEET ARE FOR CONCRETE SLAB FOUNDATION. ANY OF THE FOUNDATIONS SHOWN ON SHEETS 11-A THRU D CAN BE USED.
- 2. CONCRETE ANCHORS SHALL BE LOCATED NEXT TO EVERY POST AND ON EITHER SIDE OF OPENINGS, TWO ANCHORS SHALL BE INSTALLED AT CORNERS OF ENCLOSED BUILDINGS WITH END WALLS - ONE ON EACH BASE RAIL. IN LOCATIONS REQUIRING TWO ANCHORS DUE TO WIND, ONE ANCHOR IS TO BE ON EACH SIDE OF THE COLUMN POST.
- 3. ANCHORS IN CLOSE PROXIMITY TO EACH OTHER MUST HAVE A MIN. 4"
- 4. MIN. NUMBER OF CONCRETE ANCHORS PER POST SHALL BE AS SHOWN IN TABLE 11-A.2.
- 5. THE SIZE OF THE SLAB SHALL BE THE SIZE (WIDTH AND LENGTH) OF THE BUILDING PLUS 53" FOR 14GA MATERIAL AND 52" FOR 12GA MATERIAL.
- 6. DEPTH OF SLAB TURN DOWN FOOTING SHALL BE GREATER THAN FROST DEPTH SPECIFIED PER LOCAL CODE.
- 7. CONTROL JOINTS SHALL BE PLACED SO AS TO LIMIT MAX, SLAB SPANS TO 20' IN EACH DIRECTION.
- B. ASSUMED SOIL BEARING CAPACITY IS TO BE A MIN. OF 1500 PSF.

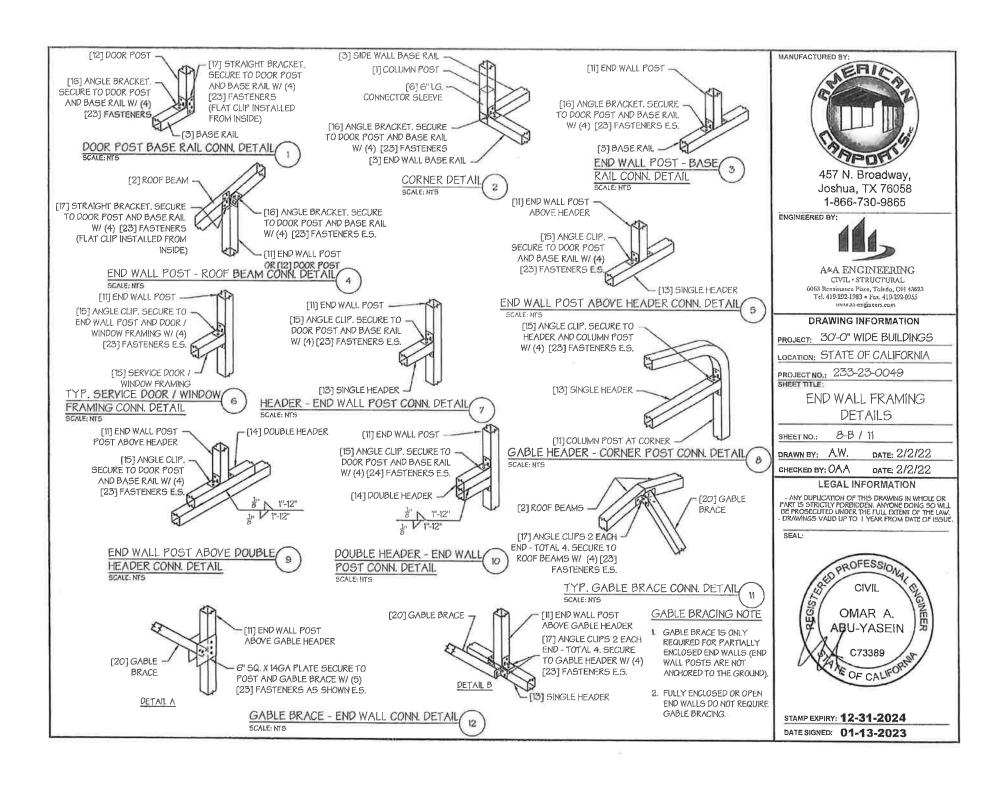BUILDING POST

2" WIDE X 1" DEEP

AND SLOPE TO 2"

NOTCH ALONG N OVERHEAD DOOR

VERTICAL

□ 12GA

17/8"

9. CONCRETE STRENGTH TO BE A MIN OF 2500 PSI @ 28 DAYS.

OVERHEAD DOOR NOTCH DETAIL

HORIZONTAL/OPEN

□12GA

NOTE: DEPTH IS TO BE 11/2"

27/8"

TABLE 11-A.1: NOTCH WIDTH

□ 14GA

13/4"

SCALE: NTS

□14GA

2 3/4"

SCALE: NTS


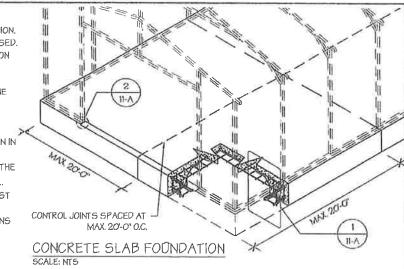



TABLE 11-A.2: CONCRETE SLAB ANCHOR SCHEDULE

WIND SPEED (MPH)	ANCHOR SIZE/NUMBER		
□105 TO 135	(1) 1/2"Ø X 7"		
□136 TO 180	(2) 1/2"Ø X 7"		
□ 105 TO 135	(1) 1/2"Ø X 7"		
□136 TO 180	(2) 1/2"Ø X 7"		
	(MPH) 105 TO 135 136 TO 180 105 TO 135		

ANCHORS ARE TO BE CONCRETE WEDGE OR EXPANSION ANCHORS.

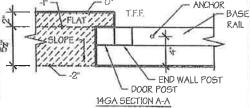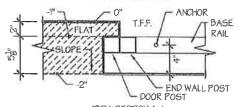- 2. MIN. EMBEDMENT DEPTH TO BE 27.
- 3. ANCHORS TO BE SPACED NO MORE THAN 6" FROM POSTS.





12GA SECTION A-A MN 4" (1) COLUMN POST EDGE DIST. MAX 6" ANCHOR - SEE TADLE 11-A.2 NOTCH - SEE TABLE 11-A.1 (1) COLUMN POST [3] BASE RAIL ANCHOR SEE TABLE 11-A2 6X6 - W2.O X W2.O WWF OR #4 REBAR @ 24" C/C E.W. -[3] PASE RAIL GRADE (MIN 2% SLOPE -AWAY FROM FDN.) NOTCH EDGE DETAIL MIN 4" THK SLAD (3) #4 REBAR CONT. **EDGE OFFSET DETAIL** SECTION B-B



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DRAWING INFORMATION

PROJECT: 30'-O" WIDE BUILDINGS

LOCATION: STATE OF CALIFORNIA

PROJECT NO.: 233-23-0049

SHEET TITLE:

FOUNDATION OPTION 1: CONCRETE SLAB

11-A / 11 SHEET NO.:


DRAWN BY: A.W. DATE: 2/2/22

CHECKED BY: OAA DATE: 2/2/22

LEGAL INFORMATION


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M. & S., Bk. 4, Pg. 6 - Murdock Subdivision P. M. Bk. 6, Pg. 81; Bk. 8, Pg. 20 P. M. Bk. 13, Pg. 53

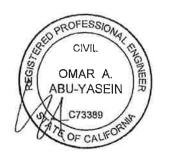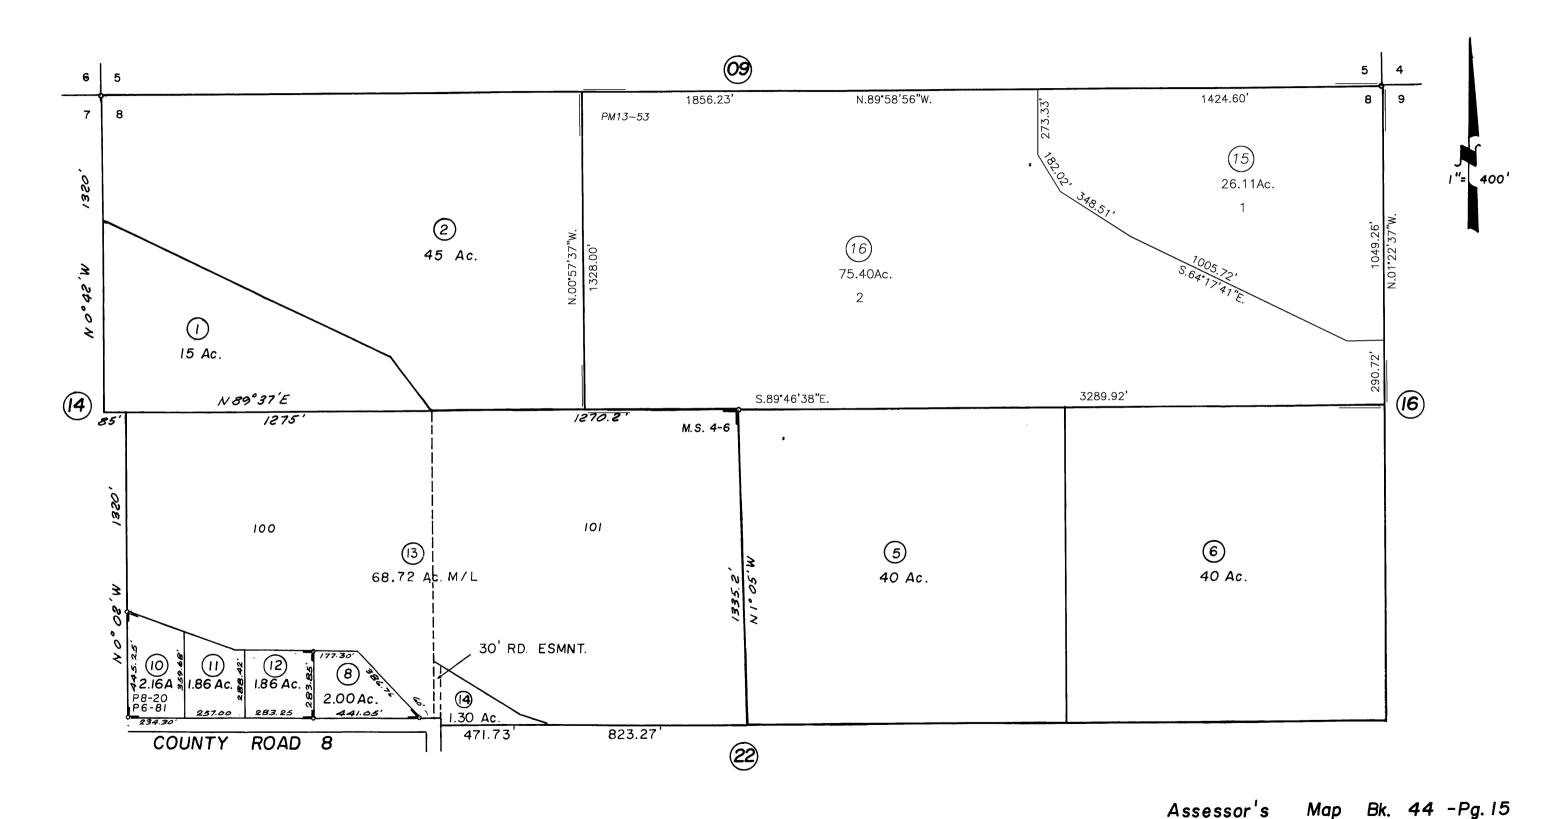NOTE - Assessor's Block Numbers Shown in Ellipses Assessor's Parcel Numbers Shown in Circles County of Glenn, Calif.

